

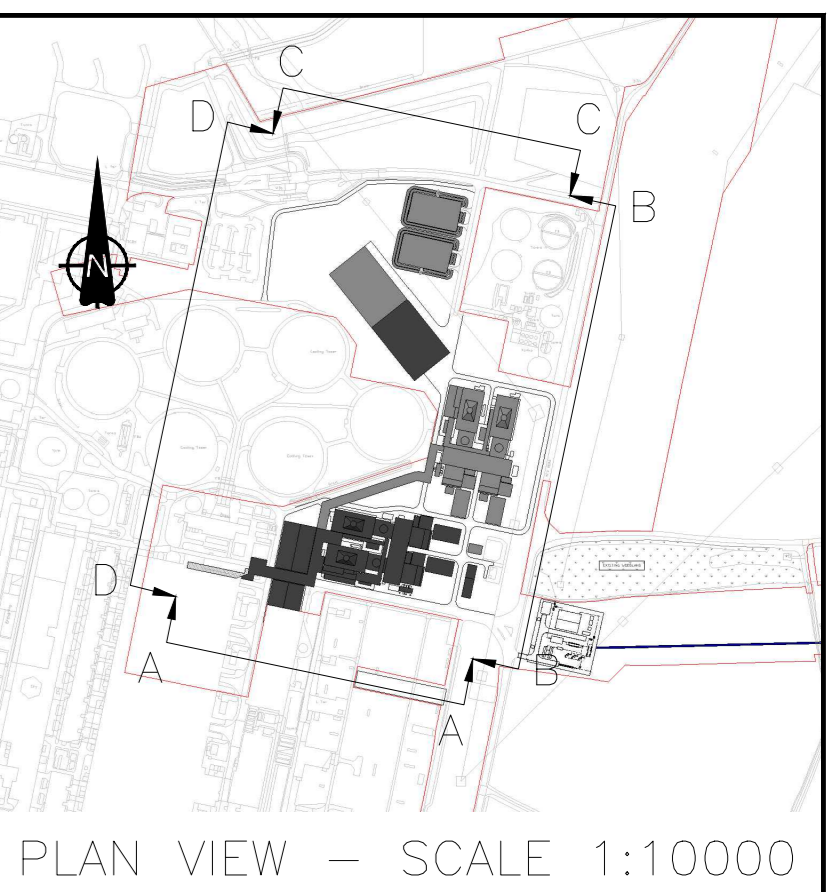


SECTION A-A SOUTH ELEVATION

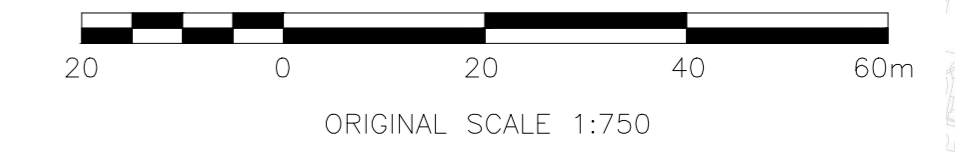


PLAN VIEW - SCALE 1:10000


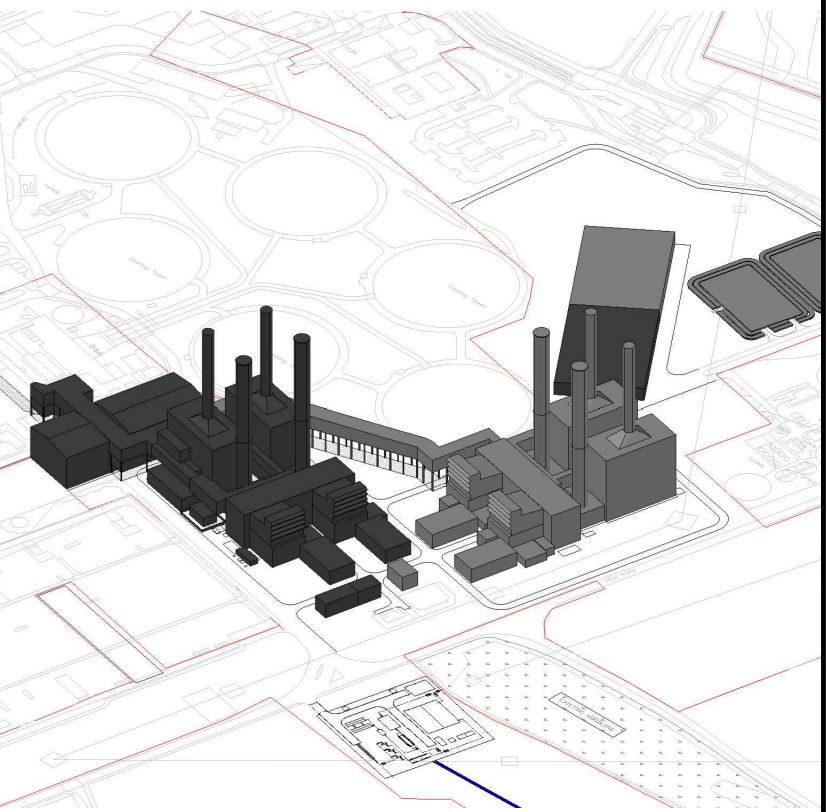


ISOMETRIC VIEW - SCALE 1:20000



NOTE:
 1. PLANT TO BE CONSTRUCTED AS PART OF ELECTRICITY GENERATING STATION UNIT X SHOWN IN A DARKER SHADE OF GREY. PLANT TO BE CONSTRUCTED AS PART OF ELECTRICITY GENERATING STATION UNIT Y SHOWN IN A LIGHTER SHADE OF GREY.
 2. ELECTRICITY GENERATING STATION FINISHED FLOOR LEVEL +6.00m AOD

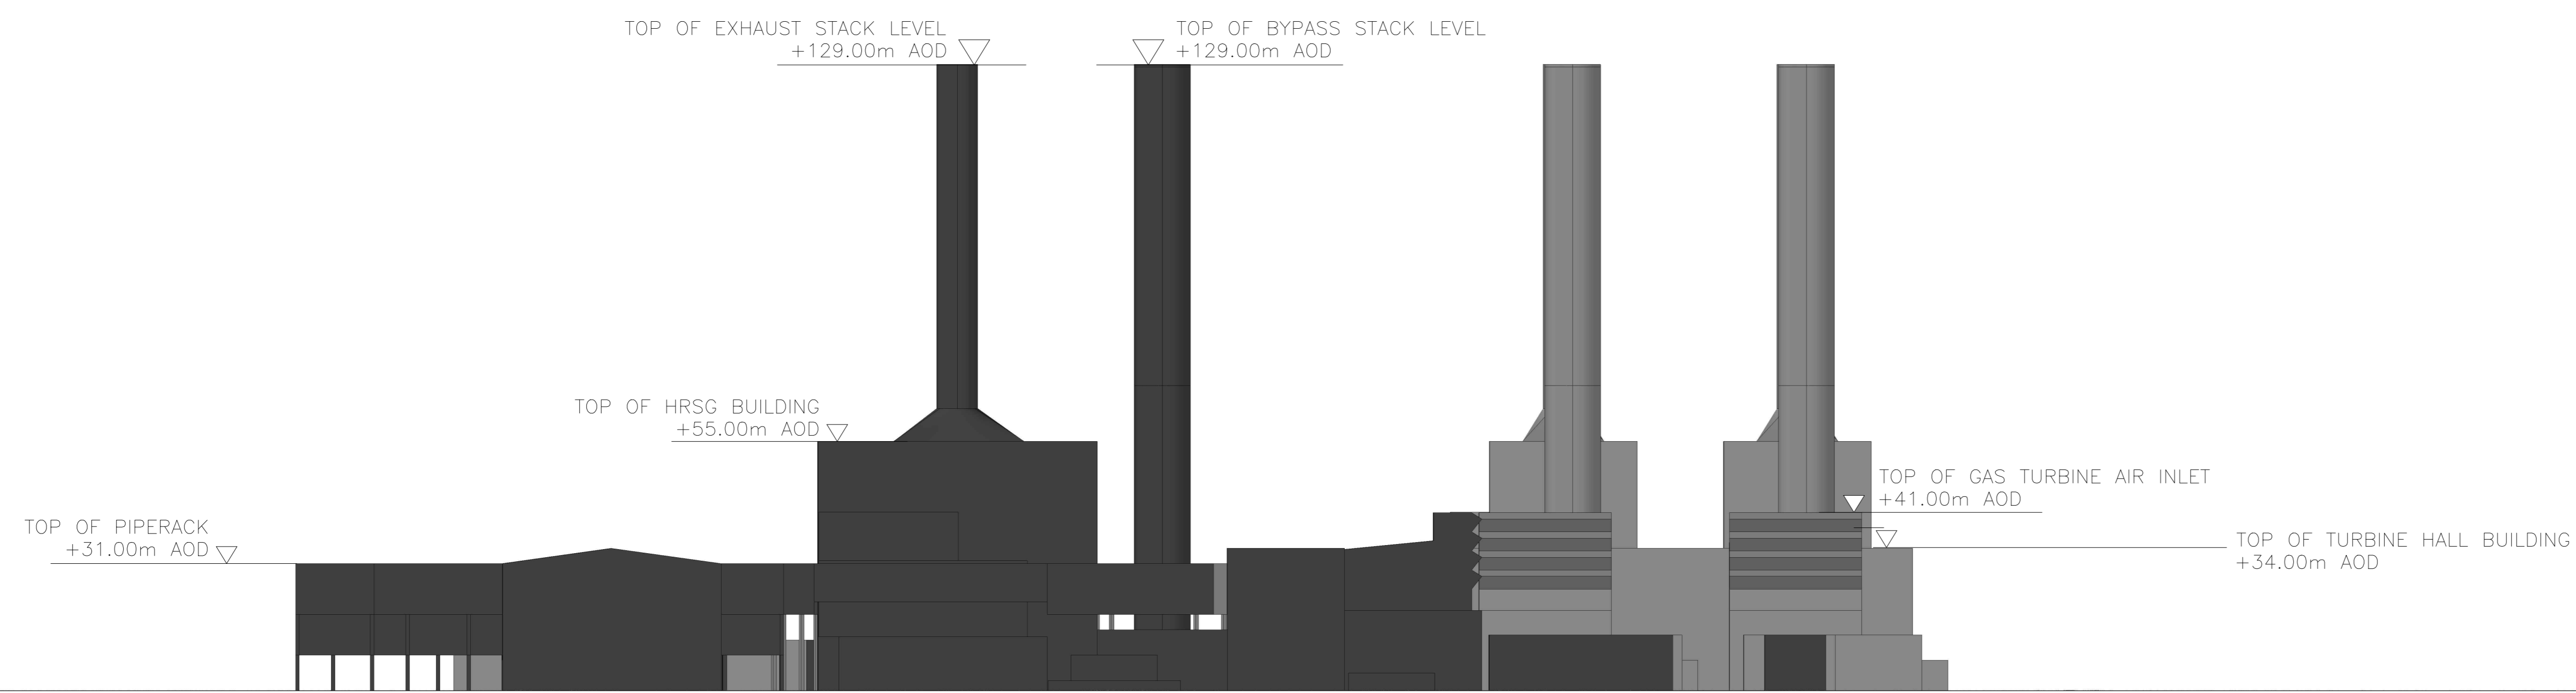



SECTION B-B EASTERN ELEVATION

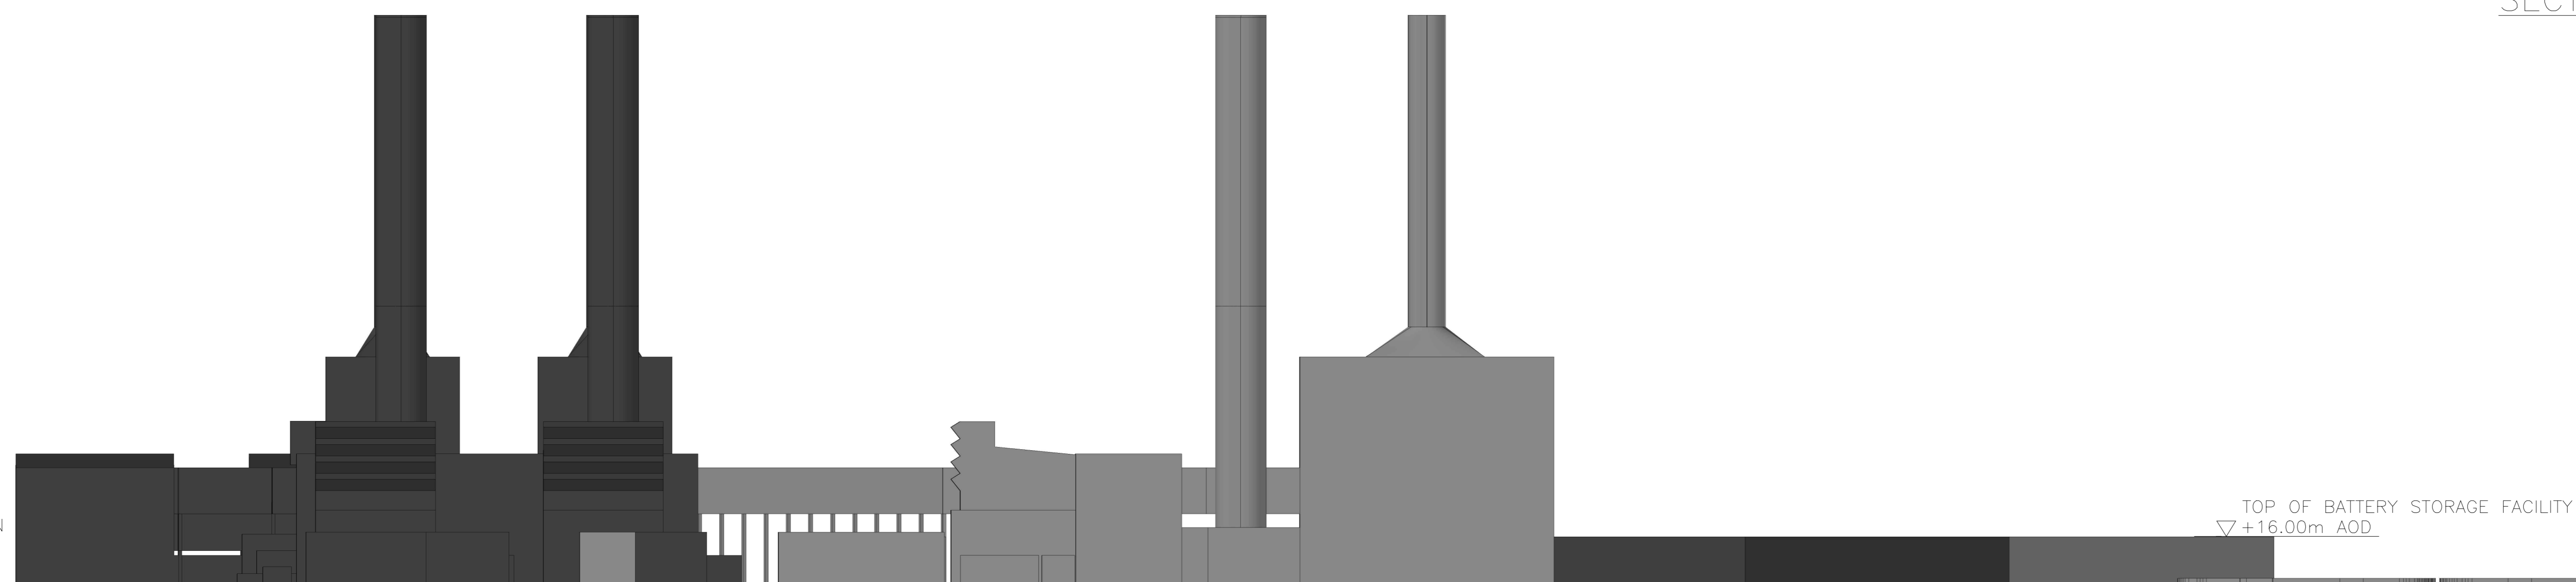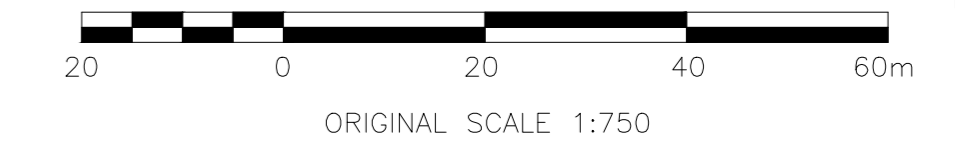

SECTION C-C NORTHERN ELEVATION

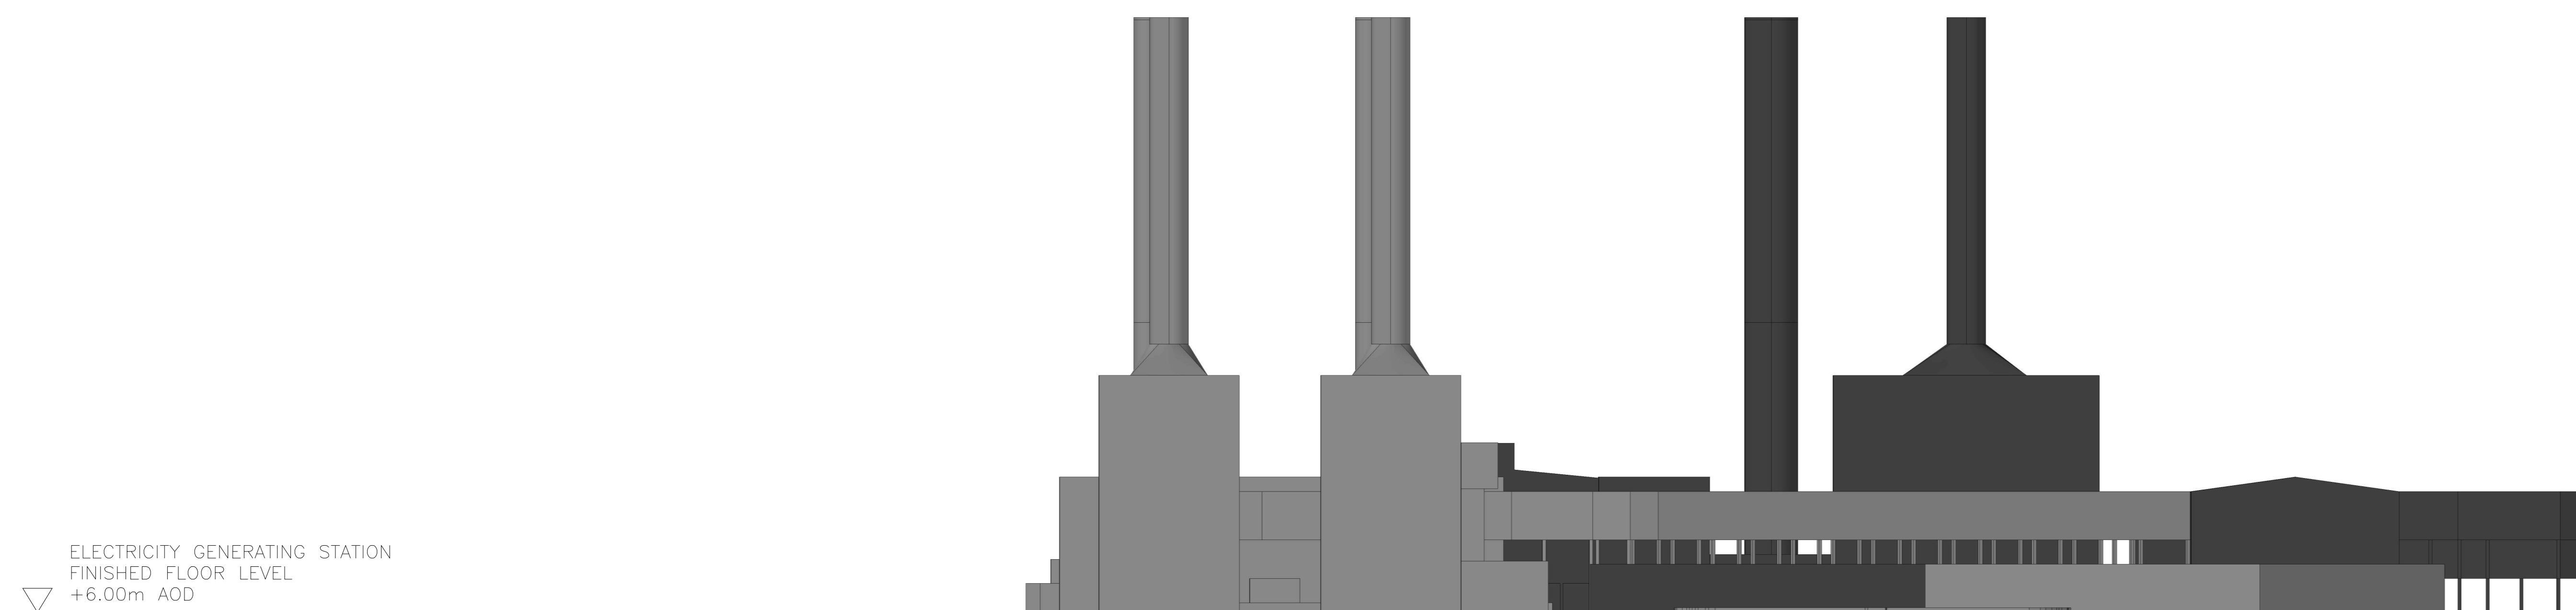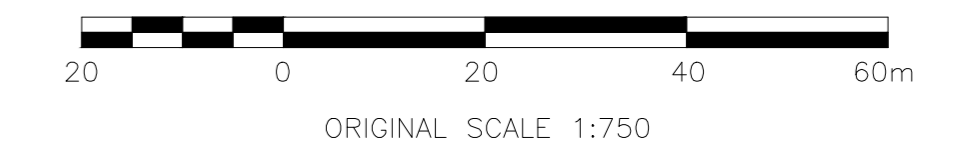

SECTION D-D WESTERN ELEVATION

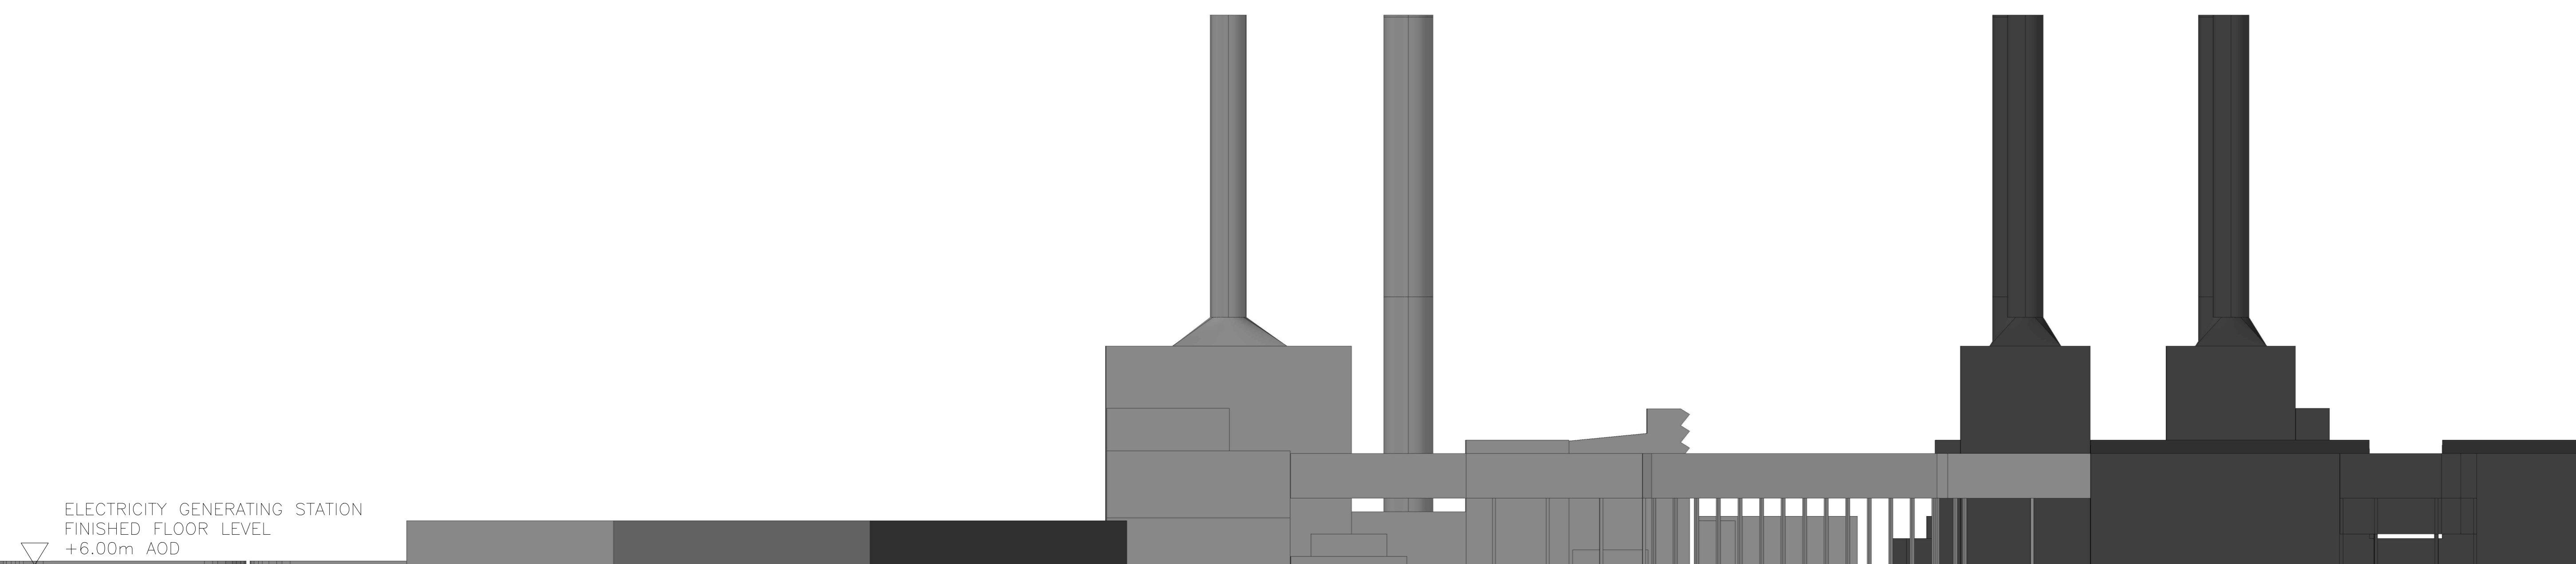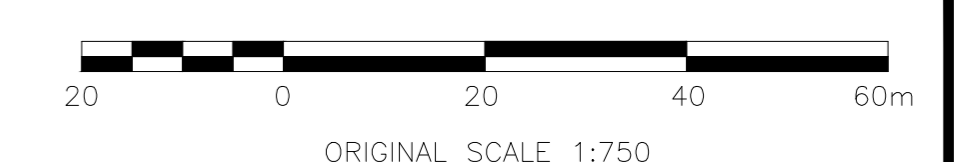

REV	DATE	BY	DESCRIPTION	CHK	APP
03	06/01/2019	SPS	THIRD ISSUE SUBMITTED FOR EXAMINATION (SCALE 5)	RK	BS
02	22/11/2018	WP	SECOND ISSUE SUBMITTED FOR EXAMINATION (SCALE 5)	RK	BS
01	06/04/2018	SPS	FIRST ISSUE	RK	BS

DRAWING STATUS: SUBMISSION FOR REFERENCE

wsp
 Westbrook Mills, Borough Road, Godalming, GU7 2AZ, UK
 T+ 44 (0) 1483 528 400, F+ 44 (0) 1483 528 989
 wsp.com

drax

PROJECT:
 The Drax Power (Generating Stations) Order

TITLE:
 Application Document Reference 2 6A - Indicative Plant Elevations

SCALE @ A0	AS SHOWN	DRAWN BY	R.MKIN	APPROVED BY	B.SIBTHORP
PROJECT NO.	70037047	ISSUED DATE	09/01/2019	DATE	09/01/2019

DRAWING NO.: 70037047-2.6A-EL REV: 03

© WSP UK Ltd

File name: \\WSP\GROUP\COMP\CENTRAL_DATA\PROJECTS\70037047\2.6A-EL-03-1 FOR SCALE LINE & DWG.dwg, Date: 07/10/2019 10:03:51, by: Spinkh, Sam